DEFINITIVE SITE PLAN CITY SQUARE - EATON PLACE

3 Eaton Place Worcester, Massachusetts 01608

FOR

FORESIGHT CAPITAL LLC

ZONING TABULATION

CURRENT ORDINANCE: ORDAINED IN CITY COUNCIL APRIL 2, 1991, AS AMENDED THROUGH APRIL 27, 2021

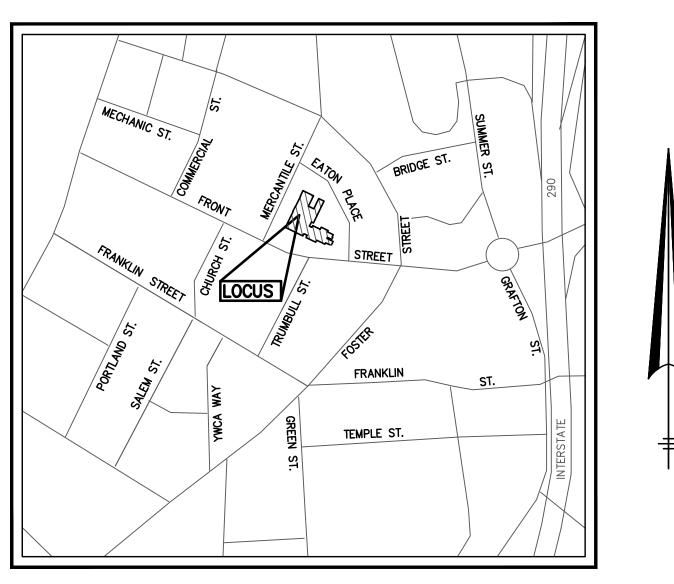
ZONE/MAP: BUSINESS, GENERAL, 6 TO 1 FAR (BG-6.0) PER ZONING MAP AMENDED THROUGH APRIL 27, 2021.

OVERLAY DISTRICTS: DOWNTOWN PARKING SUBAREA (CCOD-D) AND DOWNTOWN/BLACKSTONE CANAL SIGN DISTRICT (DSOD)

PROPOSED USE: 7-STORY MIXED-USE BUILDING - COMMERCIAL, 16,460± SF; RESIDENTIAL, 145 UNITS (69-1BR, 45-2BR, 31 STUDIO AREA: STREET LINE - 64,067± S.F. (1.47 ACRES); BACK OF SIDEWALK - 53,425± S.F. (1.23 ACRES)

REQUIRED PERMITS: PRELIMINARY SITE PLAN APPROVAL DEFINITIVE SITE PLAN APPROVAL

DIMENSIONAL REQUIREMENTS (ARTICLE IV, TABLE 4.2)					
ITEM	(ORDINANCE)	REQUIRED	PROPOSED		
MINIMUM LOT AREA		RESIDENTIAL USE: 5,000 S.F. BUSINESS USE: NOT APPLICABLE	53,425± S.F.		
MINIMUM FRONTAGE		RES. USE: 40 FT PER D.U. UP TO 200 FT BUSINESS USE: NOT APPLICABLE	1,001 FEET		
MINIMUM FRONT YARD SETBACK		NOT APPLICABLE	0 FEET		
MINIMUM SIDE YARD SETBACK		NOT APPLICABLE	NOT APPLICABLE		
MINIMUM REAR YARD SETBACK		10 FEET	NOT APPLICABLE		
MAXIMUM HEIGHT IN STORIES		NOT APPLICABLE	7 STORIES		
MAXIMUM HEIGHT IN FEET		NOT APPLICABLE	92 FEET		
MAXIMUM FLOOR TO AREA RATIO	(NOTE 11) (ART.IX, §6.C.1) 		FLOOR AREAS: 1ST = 31,981 S.F. 2ND-3RD = 35,284 S.F. 4TH-6TH = 24,293 S.F. 7TH = 24,471 S.F. G.F.A. = 199,899± S.F. F.A.R. = 199,899/53,425 = 3.7:1		
PARKING R	<u> </u>	RTICLE IV, TABLE 4.4; ARTICLE IX,	TABLE 9.1)		
ITEM	(ORDINANCE)	REQUIRED	PROPOSED		
MINIMUM PARKING SPACES	(T.4.4, NOTE 1.b)	NO ACCESSORY PARKING IS REQUIRED IN A BG-6.0 DISTRICT.	ALL SPACES ARE LEASED WITHIN CITY SQUARE GARAGE.		
MAXIMUM PARKING SPACES		RESIDENTIAL MULTI-FAMILY: 2 SP. PER D.U. (TOTAL, INCLUDING RESIDENT AND GUEST PARKING) BUSINESS OFFICE/RETAIL: 1 SP. PER 250 S.F. BUSINESS FOOD SERVICE: 1 SP. PER 2 RATED OCCUPANCY	RESIDENTIAL: 145 SPACES (1 SP / UNIT) RESTAURANT: 48 SPACES (1 SP / 2.5± PERSONS) RETAIL: 35 SPACES (1 SP / 300± SF) TOTAL = 228 SPACES		
MINIMUM AISLE WIDTH	(T.4.4, NOTE 2.b)	24 FEET	10176 - 220 31 7023		
CONVENTIONAL SPACE DIMENSIONS	(T.4.4, NOTE 3.a)	9 FT WIDTH x 18 FT LENGTH			
COMPACT SPACE DIMENSIONS	(T.4.4, NOTE 3.b)	25% ALLOWED AS A MATTER OF RIGHT 8 FT WIDTH x 16 FT LENGTH			
LOADING REQUIREMENTS (ARTICLE IV, TABLE 4.5)					
	LOADING REQUIR	EMENTS (ARTICLE IV, TABLE 4.5)			
ITEM	(ORDINANCE)	REQUIRED	PROPOSED		
ITEM MINIMUM LOADING SPACES		· · · · · · · · · · · · · · · · · · ·	PROPOSED 1 SPACE PROVIDED		



LOCUS MAP

SCALE 1 INCH = 500 FEET
250 500 1000 20

RECORD OWNER:

FORESIGHT CAPITAL LLC 125 GOFF AVENUE PAWTUCKET, RI 02860 FORESIGHT CAPITAL LLC 125 GOFF AVENUE

PAWTUCKET, RI 02860

APPLICANT:

<u>CIVIL ENGINEER:</u>

HANCOCK ASSOCIATES
315 ELM STREET
MARLBOROUGH, MA 01752
(508) 460-1111

LAND SURVEYOR:

NITSCH ENGINEERING
370 MAIN STREET

SUITE 850 WORCESTER, MA 01608 (508) 365-1030

<u>ARCHITECT:</u>

LAGRASSE YANOWITZ & FEYL (LYF)

1 ELM SQUARE

ANDOVER, MA 01810

(978) 470-3675

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SHEET 5	C5	EROSION AND SEDIMENT CONTROL PLAN
SHEET 6-7	C6-C7	DETAILS SHEET

SITE ADDRESS:

| CITY SQUARE | EATON PLACE

3 Eaton Place Worcester, Massachusetts 01608

ASSESSORS:

\underline{MAP}	BLOCK	<u>LOT</u>
2	23B	00A-1

PREPARED FOR:

FORESIGHT CAPITAL LLC

125 Goff Avenue, Suite 2101 Pawtucket, RI 02860

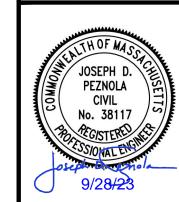
HANCOCK ASSOCIATES

Civil Engineers

Land Surveyors

Environmental Consultants

315 Elm Street, Marlborough, MA 01752 Voice (508) 460-1111, Fax (508) 460-1121 www.hancockassociates.com



NO.	BY	APP	DATE		SUE/REVISION D	
DAT	E:	9	/28/202	23	DESIGN BY:	RMD

SCALE: --- DRAWN BY: RMD APPROVED BY: JDP CHECK BY: KAC

TITLE SHEET

PLOT DATE: Sep 27, 2023 12:53 pm

DWG: 26660DSP.dwg

LAYOUT: TS

SHEET: 1 OF 7

PROJECT NO.:

26660

PURPOSE AND INTENT

1. THIS PLAN SET IS SUBMITTED FOR DEIFNITIVE SITE PLAN APPROVAL

GENERAL NOTES

- THE CONTRACTOR SHALL VERIFY THE LOCATION AND RELATIVE ELEVATION OF BENCH MARKS PRIOR TO COMMENCEMENT OF CONSTRUCTION. ANY DISCREPANCY SHALL BE REPORTED TO THE ENGINEER.
- 2. CONTRACTOR SHALL FURNISH CONSTRUCTION LAYOUT OF BUILDING AND SITE IMPROVEMENTS. THIS WORK SHALL BE PERFORMED BY A PROFESSIONAL LAND SURVEYOR.
- 3. SAFETY MEASURES. CONSTRUCTION METHODS AND CONTROL OF WORK SHALL BE RESPONSIBILITY OF THE CONTRACTOR.
- 4. ALL SITE CONSTRUCTION SHALL COMPLY WITH THE WORCESTER DEPARTMENT OF PUBLIC WORKS STANDARDS.
- 5. CONTRACTOR SHALL BE RESPONSIBLE FOR REPAIR AND/OR REPLACEMENT OF ANY EXISTING IMPROVEMENTS DAMAGED DURING CONSTRUCTION THAT ARE NOT DESIGNATED FOR DEMOLITION AND / OR REMOVAL HEREON. DAMAGED IMPROVEMENTS SHALL BE REPAIRED TO THE SATISFACTION OF THEIR RESPECTIVE OWNERS.
- 6. ANY INTENDED REVISION OF THE HORIZONTAL AND/OR VERTICAL LOCATION OF IMPROVEMENTS TO BE CONSTRUCTED AS SHOWN HEREON SHALL BE REVIEWED AND APPROVED BY ENGINEER PRIOR TO IMPLEMENTATION.
- 7. THIS PLAN IS NOT INTENDED TO SHOW AN ENGINEERED BUILDING FOUNDATION DESIGN, WHICH WOULD INCLUDE DETAILS AND FINAL ELEVATIONS OF FOOTINGS, WALLS AND SUBSURFACE DRAINAGE TO PREVENT INTERIOR FLOODING. SEE ARCHITECTURAL AND/OR STRUCTURAL DRAWINGS.
- 8. PROPOSED BUILDING FOUNDATION CONFIGURATION AND LOCATION ON THE LOT AS SHOWN ARE CONCEPTUAL AND SHALL BE VERIFIED AS TO CONFORMANCE WITH FINAL ARCHITECTURAL PLANS AND ZONING ORDINANCES PRIOR TO CONSTRUCTION.
- 9. THE CONTRACTOR SHALL BE RESPONSIBLE FOR RECORDING HORIZONTAL AND VERTICAL MEASUREMENTS FOR ALL SUBSURFACE STRUCTURES. THIS INFORMATION SHALL BE REPORTED TO THE ENGINEER.
- 10. TRASH AND RECYCLING COLLECTION AREAS ARE LOCATED WITHIN THE BUILDINGS.
- 11. STANDARD PARKING SPACES ARE 9'X 18', TYPICAL SITE DRIVEWAYS ARE 24' WIDE. HANDICAP PARKING SPACES AND RAMPS SHALL MEET ADA AND MASSDOT REQUIREMENTS.
- 12. LOCATIONS OF EXISTING UNDERGROUND UTILITIES / OBSTRUCTIONS / SYSTEMS SHOWN HEREON ARE APPROXIMATE ONLY. ALL UTILITIES / OBSTRUCTIONS / SYSTEMS MAY NOT BE SHOWN. CONTRACTOR SHALL BE RESPONSIBLE FOR LOCATING AND PROTECTING ALL UNDERGROUND UTILITIES / OBSTRUCTIONS / SYSTEMS, WHETHER OR NOT SHOWN HEREON.
- 13. UNLESS OTHERWISE SHOWN, ALL NEW UTILITIES SHALL BE UNDERGROUND.
- 14. RIM ELEVATIONS SHOWN FOR NEW STRUCTURES ARE APPROXIMATE AND ARE PROVIDED TO ASSIST CONTRACTOR WITH MATERIAL TAKEOFFS. FINISH RIM ELEVATIONS SHOULD MATCH PAVEMENT, GRADING OR LANDSCAPING, UNLESS SPECIFICALLY INDICATED OTHERWISE.
- 15. WHERE EXISTING UTILITY LINES / STRUCTURES ARE TO BE CUT / BROKEN DOWN / ABANDONED, LINES / STRUCTURES SHALL BE PLUGGED / CAPPED / FILLED IN ACCORDANCE WITH OWNER REQUIREMENTS.
- 16. THE CONTRACTOR SHALL ENCASE AND/OR SLEEVE SEWER AND WATER MAINS WHERE THE CROWN OF THE SEWER PIPE IS LESS THAN 18 INCHES BELOW THE INVERT OF THE WATER PIPE AND WHERE THE HORIZONTAL SEPARATION IS LESS THAN 10 FEET, AS REQUIRED BY THE MASSACHUSETTS DEPARTMENT OF ENVIRONMENTAL PROTECTION.
- 17. STRUCTURE DETAILS FROM INDEPENDENT VENDORS ARE CONSTANTLY CHANGING. PRIOR TO CONSTRUCTION, THE CONTRACTOR SHALL VERIFY THAT DETAILS SHOWN MATCH CURRENT DETAILS AND SPECIFICATIONS FROM VENDORS.
- 18. ALL PROPOSED TOP OF VERTICAL CURB ELEVATIONS ARE 6 INCHES ABOVE THE BOTTOM OF CURB UNLESS OTHERWISE SHOWN.
- 19. WHERE NEW PAVING MEETS EXISTING PAVING, MEET LINE AND GRADE OF EXISTING WITH NEW PAVING.
- 20. AT LOCATIONS WHERE EXISTING PAVEMENT ABUTS NEW CONSTRUCTION, THE EDGE OF THE EXISTING PAVEMENT SHALL BE SAWCUT TO A CLEAN, SMOOTH EDGE.
- 21. EXCAVATION REQUIRED WITHIN PROXIMITY OF EXISTING UTILITY LINES SHALL BE DONE BY HAND. CONTRACTOR SHALL REPAIR ANY DAMAGE TO EXISTING UTILITY LINES OR STRUCTURES INCURRED DURING CONSTRUCTION OPERATIONS AT NO ADDITIONAL COST TO THE
- 22. CONTRACTOR SHALL VERIFY ALL PROPOSED TOP OF CURB ELEVATIONS BEFORE PROCEEDING WITH ANY CONSTRUCTION AND ADVISE THE ENGINEER OF ANY DISCREPANCY WHICH MAY IMPACT DESIGN.
- 23. ALL DISTURBED AREAS NOT COVERED WITH PAVEMENT, STRUCTURES, INDIVIDUAL PLANTINGS. OR MULCH SHALL HAVE LOAM AND SOD. OR LOAM AND SEED AS SHOWN ON THE LANDSCAPE PLANS OR AS DIRECTED BY THE ENGINEER.
- 24. ALL UNDERGROUND STRUCTURES AND UTILITIES SHALL BE CAPABLE OF WITHSTANDING H20 WHEEL LOADS.
- 25. THE CONTRACTOR SHALL FIELD VERIFY THE LOCATION, SIZE, INVERTS AND TYPES OF EXISTING PIPES AT ALL PROPOSED POINTS OF CONNECTION PRIOR TO ORDERING MATERIALS. WHERE AN EXISTING UTILITY IS FOUND TO CONFLICT WITH THE PROPOSED WORK. THE LOCATION, ELEVATION AND SIZE OF THE UTILITY SHALL BE ACCURATELY DETERMINED WITHOUT DELAY AT NO ADDITIONAL COST BY THE CONTRACTOR, AND THE INFORMATION FURNISHED IN WRITING TO THE OWNER'S REPRESENTATIVE FOR THE RESOLUTION OF THE CONFLICT.
- 26. CONTRACTOR SHALL PROVIDE DUST CONTROL FOR CONSTRUCTION OPERATIONS AS APPROVED BY THE ENGINEER.
- 27. ALL POINTS OF CONSTRUCTION EGRESS OR INGRESS SHALL BE MAINTAINED TO PREVENT TRACKING OR FLOWING OF SEDIMENT ON TO PUBLIC ROADS.
- 28. SEE LANDSCAPE PLANS FOR GRADING, LAYOUT AND PLANTING IN THE COURTYARD. SEE ARCHITECTURAL PLANS FOR DETAILS AND MATERIALS OF STEPS, WALLS, AND WALKWAYS.

SURVEY NOTES

- 1. PROJECT SOURCE BENCHMARK, RECORD LOCATIONS OF UTILITIES AND STRUCTURES, AND SERVICE CONNECTIONS ARE BASED ON A PLAN BY NITSCH ENGINEERING ENTITLED "EXISTING CONDITIONS PLAN, CITY SQUARE, EATON PLACE, WORCESTER, MASSACHUSETTS," DATED SEPTEMBER 21, 2023.
- 2. UNDERGROUND UTILITIES SHOWN HEREON ARE COMPILED FROM FIELD LOCATIONS OF STRUCTURES AND FROM AVAILABLE RECORD INFORMATION ON FILE AT THE CITY ENGINEERING OFFICES, CITY D.P.W., MASS HIGHWAY DEPT. AND UTILITY COMPANIES. OTHER UNDERGROUND UTILITIES MAY EXIST. IT SHALL BE THE RESPONSIBILITY OF THE CONTRACTOR TO VERIFY THE LOCATION. SIZE & ELEVATION OF ALL UTILITIES WITHIN THE AREA OF PROPOSED WORK AND TO CONTACT "DIG-SAFE" AT 811 AT LEAST 72 HOURS PRIOR TO ANY EXCAVATION. DEMOLITION OR CONSTRUCTION.

REGULATORY NOTES

- 1. CONTRACTOR SHALL CONTACT "DIG-SAFE" FOR AN UNDERGROUND UTILITY MARKING AT 811 AT LEAST 72 HOURS PRIOR TO THE COMMENCEMENT OF ANY WORK.
- 2. CONTRACTOR SHALL MAKE HIMSELF AWARE OF ALL CONSTRUCTION REQUIREMENTS, CONDITIONS AND LIMITATIONS IMPOSED BY PERMITS AND APPROVALS ISSUED BY REGULATORY AUTHORITIES PRIOR TO THE COMMENCEMENT OF ANY WORK. CONTRACTOR SHALL COORDINATE AND OBTAIN ALL CONSTRUCTION PERMITS REQUIRED BY REGULATORY AUTHORITIES.
- 3. ALL WORK OUTSIDE OF THE BUILDING THAT IS LESS THAN 10 FEET FROM THE INSIDE FACE OF THE BUILDING FOUNDATION SHALL CONFORM WITH THE UNIFORM STATE PLUMBING CODE OF MASSACHUSETTS. 248 CMR 2.00.
- 4. CONSTRUCTION ACTIVITIES SHALL CONFORM TO THE RULES AND REGULATIONS OF THE OCCUPATIONAL SAFETY AND HEALTH ADMINISTRATION (OSHA).
- 5. CONTRACTOR SHALL INSTALL ALL PARKING AREAS AND WALKWAYS IN ACCORDANCE WITH APPLICABLE ADA AND MAAB REQUIREMENTS, INCLUDING BUT NOT LIMITED TO THE FOLLOWING:
- HANDICAPPED SPACES AND STRIPED AREA SLOPES SHALL NOT EXCEED 2% IN ANY DIRECTION. - HANDICAPPED RAMPS SHALL NOT EXCEED 8% FOR A MAXIMUM VERTICAL DISTANCE OF 6 INCHES.
- SIDEWALKS SHALL HAVE A MAXIMUM SLOPE IN THE PATH OF TRAVEL OF 5% AND A MAXIMUM CROSS SLOPE OF 2%. CONTRACTOR SHOULD NOT LAYOUT SLOPES EXCEEDING 4.5% AND 1.5% RESPECTIVELY TO ALLOW FOR CONSTRUCTION TOLERANCES. IF THE CONTRACTOR DETERMINES THAT THE REQUIRED SLOPES CANNOT BE ACHIEVED, THE CONTRACTOR SHALL BE RESPONSIBLE FOR REPORTING THE INFORMATION TO THE ENGINEER FOR RESOLUTION.

ASSESSORS:

ZONING:

BG-6, (CCOD-D & DSOD OVERLAY)

REFERENCES:

DEED BOOK 46426, PAGE 196 PLAN BOOK 490, PLAN 83 PLAN BOOK 918, PLAN 52 DEED BOOK 57288, PAGE 329 (EASE.)

LANDSCAPING/GRASS

CONCRETE WALKWAY

TREE ABBREVIATIONS

CH

MAPLE

OAKPINE

CHERRY

APPLE

RECORD OWNER:

FORESIGHT CAPITAL LLC 125 GOFF AVENUE PAWTUCKET, RI 02860

MAP 2, BLOCK 23B, LOT 00A-1

CITY SQUARE EATON PLACE

3 Eaton Place Worcester, Massachusetts 01608

ASSESSORS:

SITE ADDRESS:

BLOCK 23B 00A-1

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125 Goff Avenue, Suite 2101 Pawtucket, RI 02860

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NO. BY APP DATE ISSUE/REVISION DESCRIPTION 9/28/2023 DESIGN BY:

APPROVED BY: JDP CHECK BY:

NOTES & **LEGEND**

--- DRAWN BY:

RMD

KAC

PLOT DATE: Sep 27, 2023 12:53 pm DWG: 26660DSP.dwg AYOUT:

SHEET: 2 OF 7

PROJECT NO.:

26660

LEGEND

SPOT ELEVATION

ELECTRIC MANHOLE & UNDERGROUND ©—— E — ELECTRIC LINES TELEPHONE MANHOLE & UNDERGROUND TELEPHONE LINES WATER MANHOLE, WATER MAIN WITH SIZE, TEE, GATE VALVE &

FIRE HYDRANT GAS MAIN WITH SIZE & GATE VALVE

EDGE OF PAVEMENT CURB WITH TOP AND BOTTOM CURB ELEVATION

SEWERLINE & MANHOLE WITH PIPE SIZE, MATERIAL & FLOW DIRECTION DRAINLINE WITH PIPE SIZE, MATERIAL & FLOW DIRECTION, CATCHBASIN, MANHOLE & ROUND CATCHBASIN

-----L3------ COMMUNICATION LINE PAINT MARK RETAINING WALL

LS TYP05 A.D.

SMH

VGC

VCC

HH

NFO

NPV

TOH

CU

× *232.6* PROMINENT CONIFEROUS TREE WITH ELEVATION, SIZE AND SPECIES PROMINENT DECIDUOUS TREE WITH ELEVATION, SIZE AND SPECIES

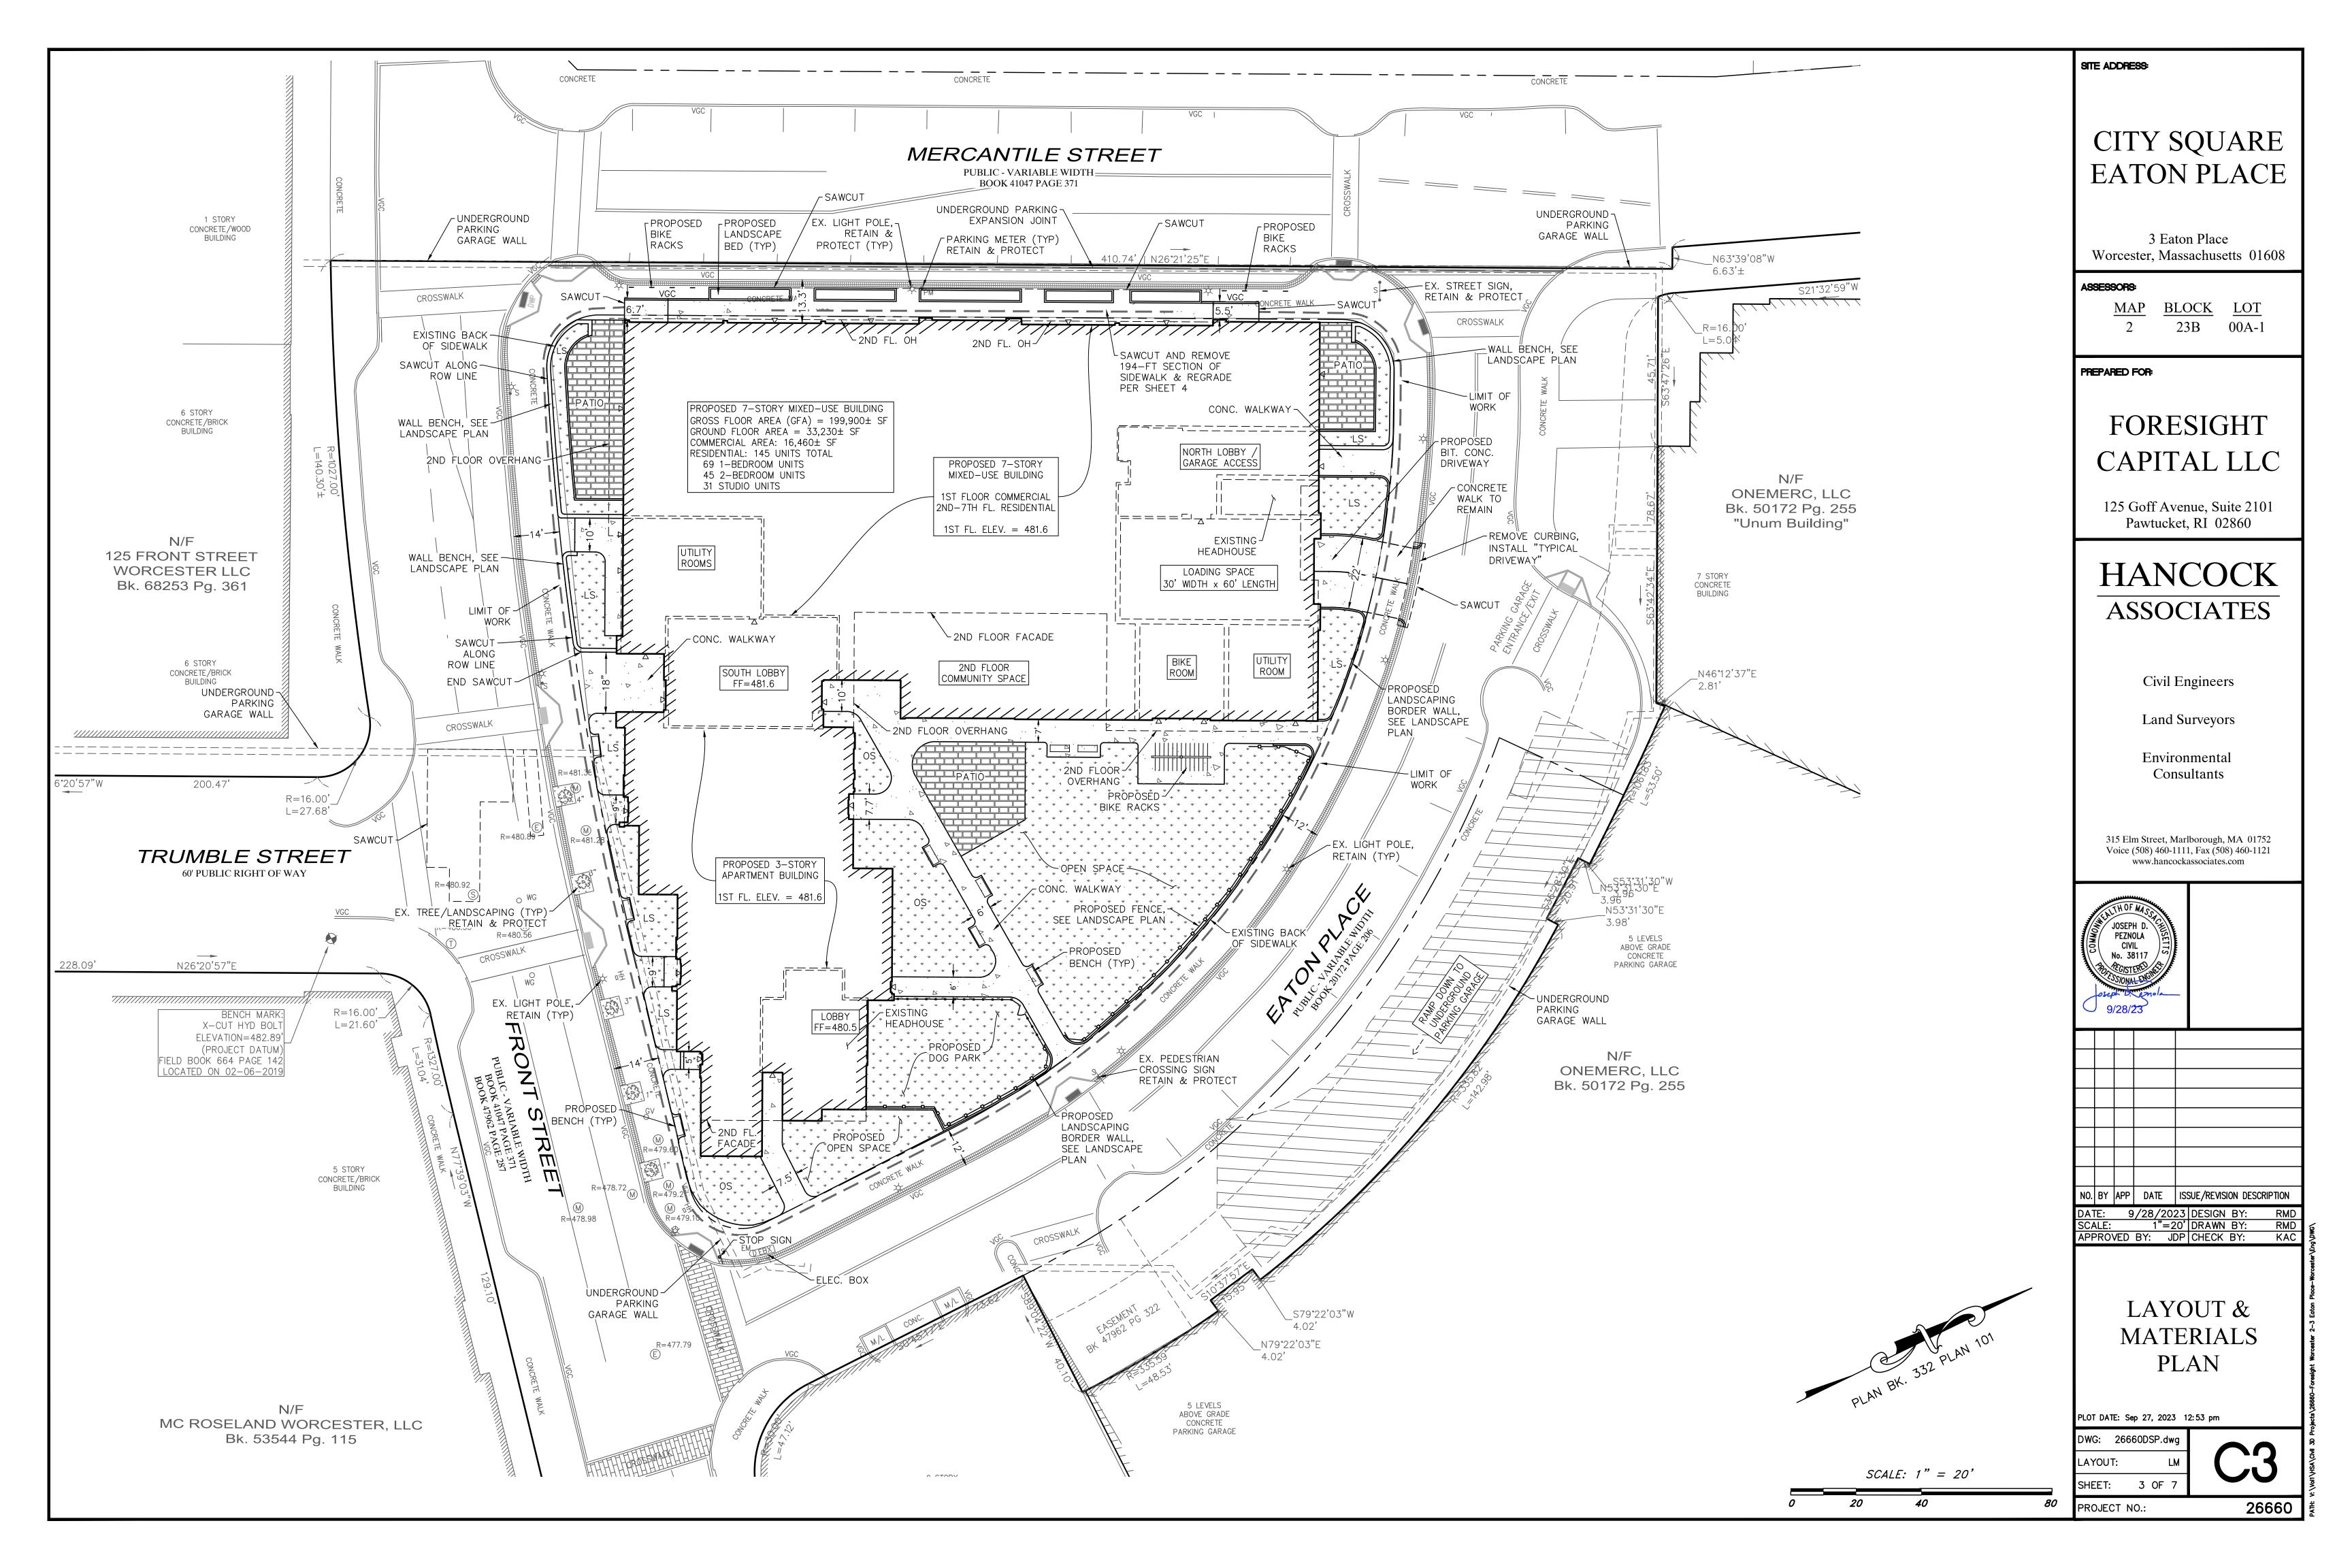
> LIGHT POLE REINFORCED CONCRETE PIPE SEWER MANHOLE DRAIN MANHOLE

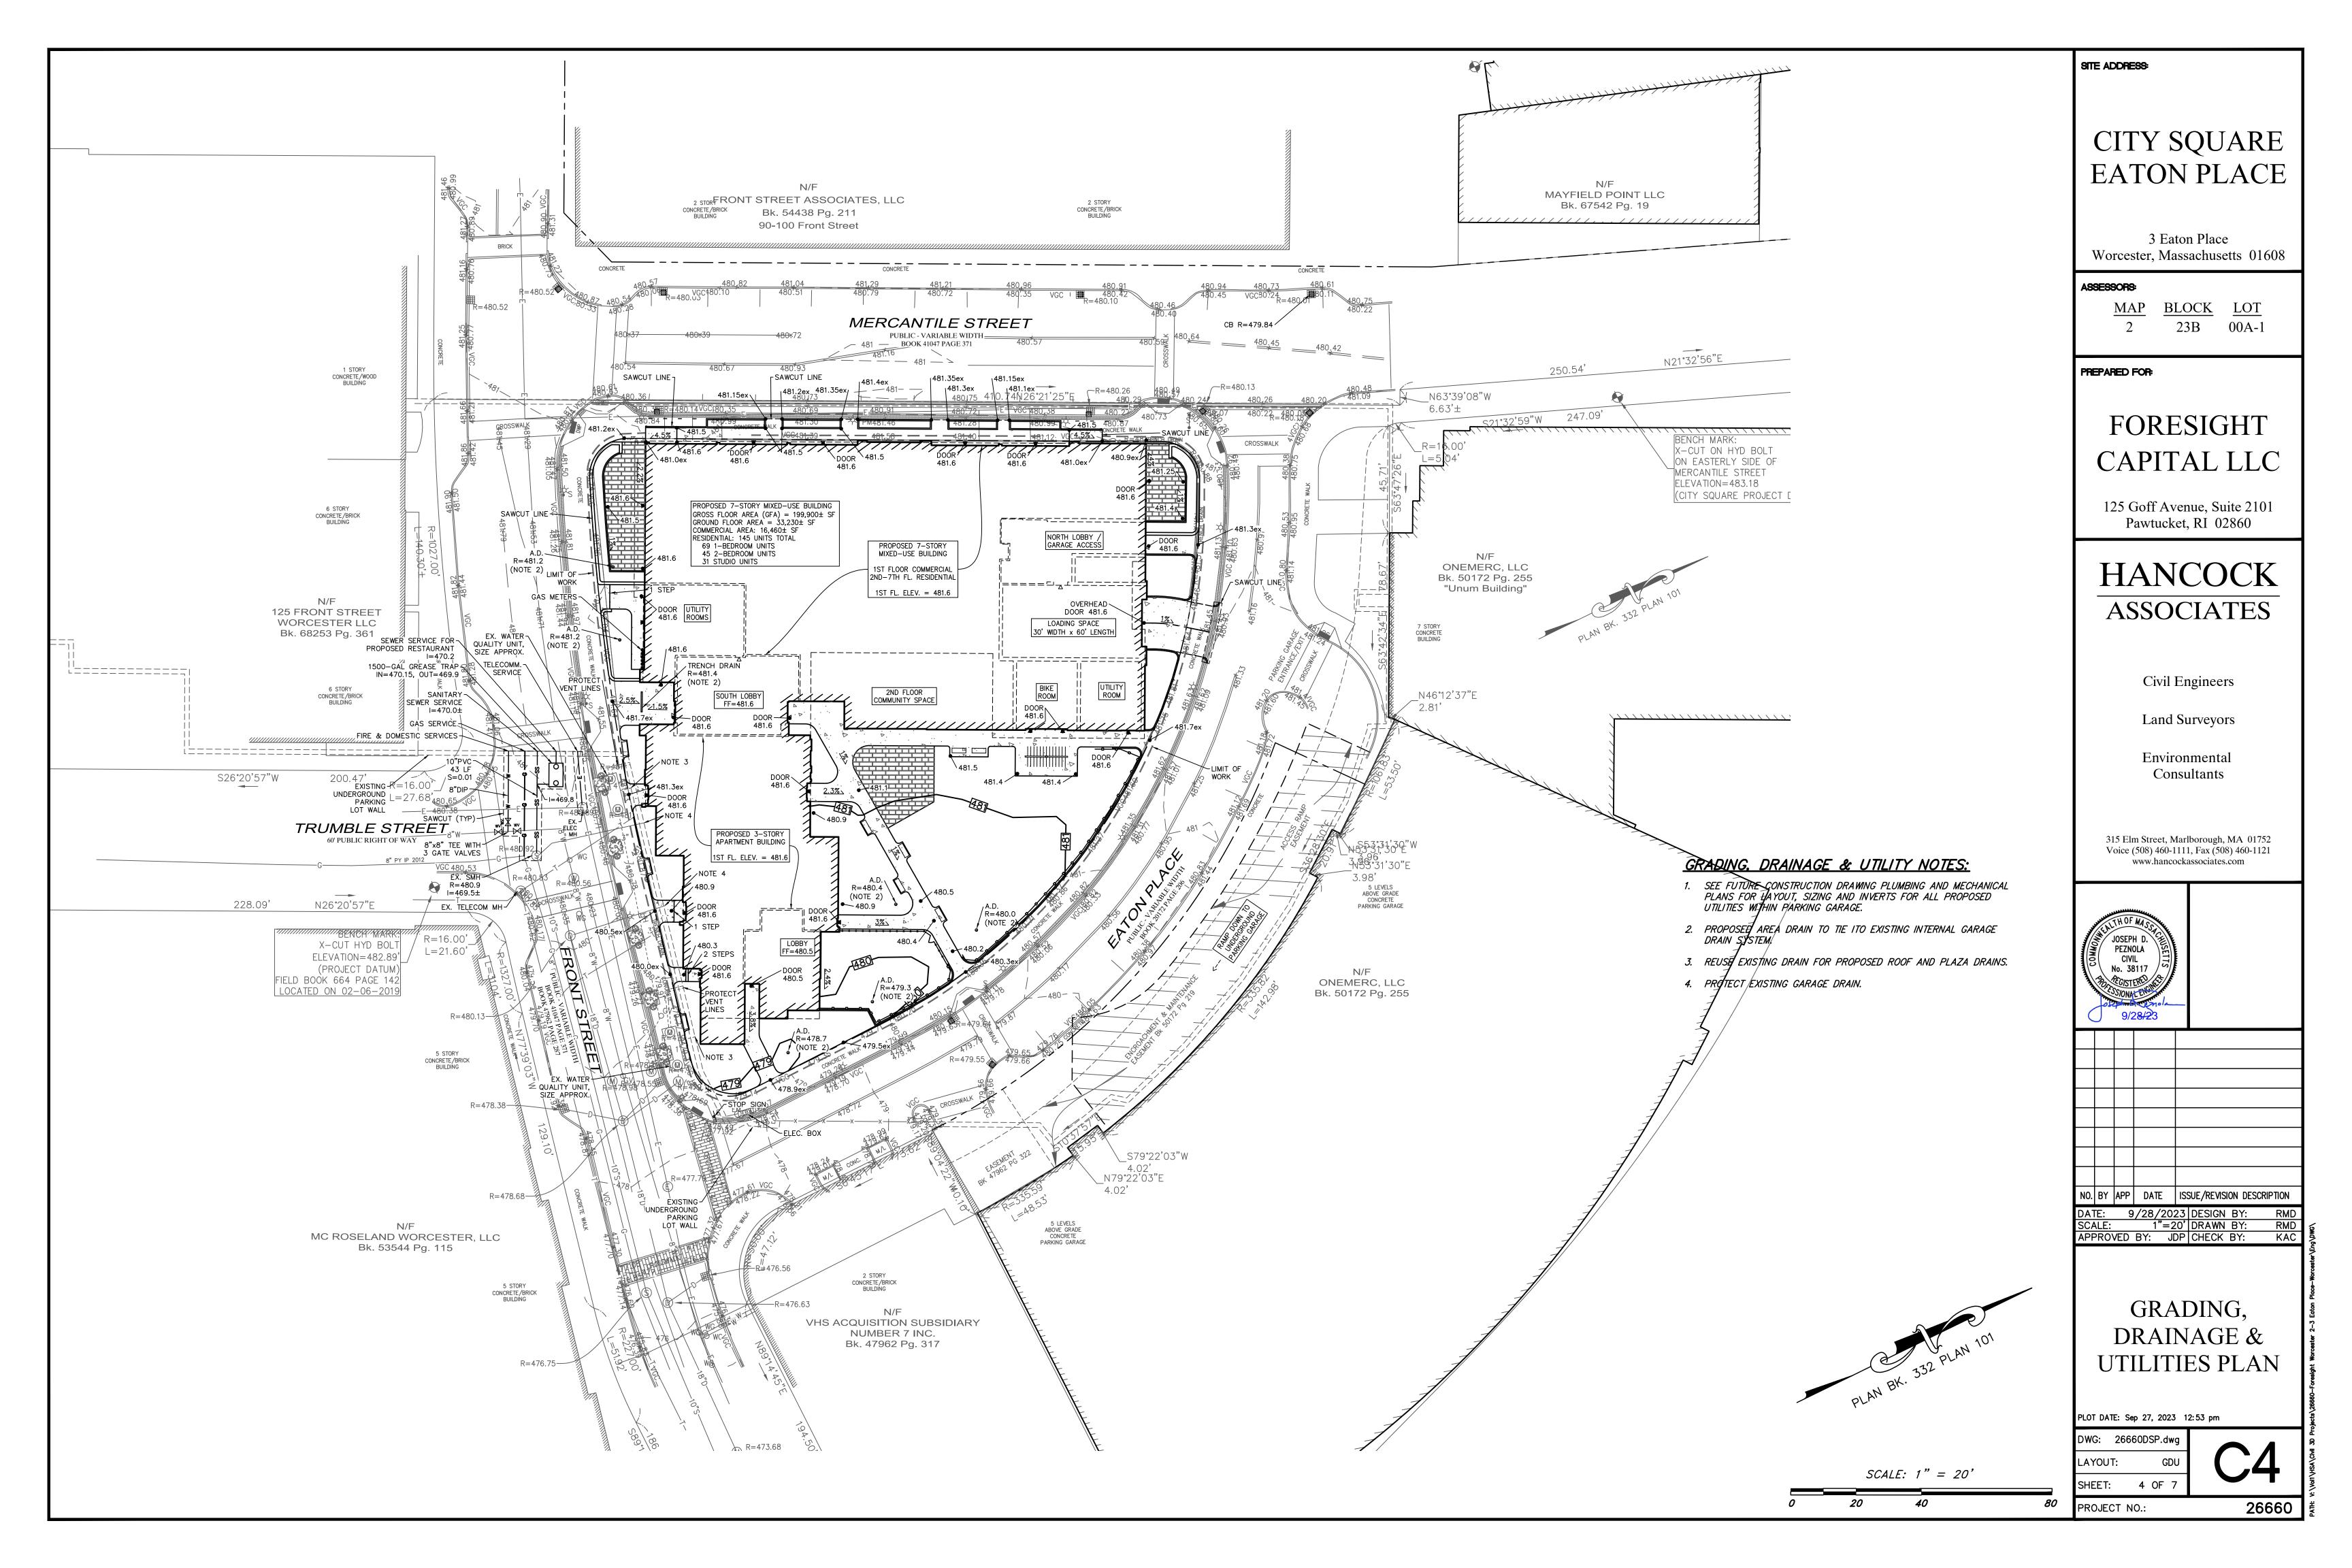
CATCH BASIN ROUND CATCH BASIN SIGN

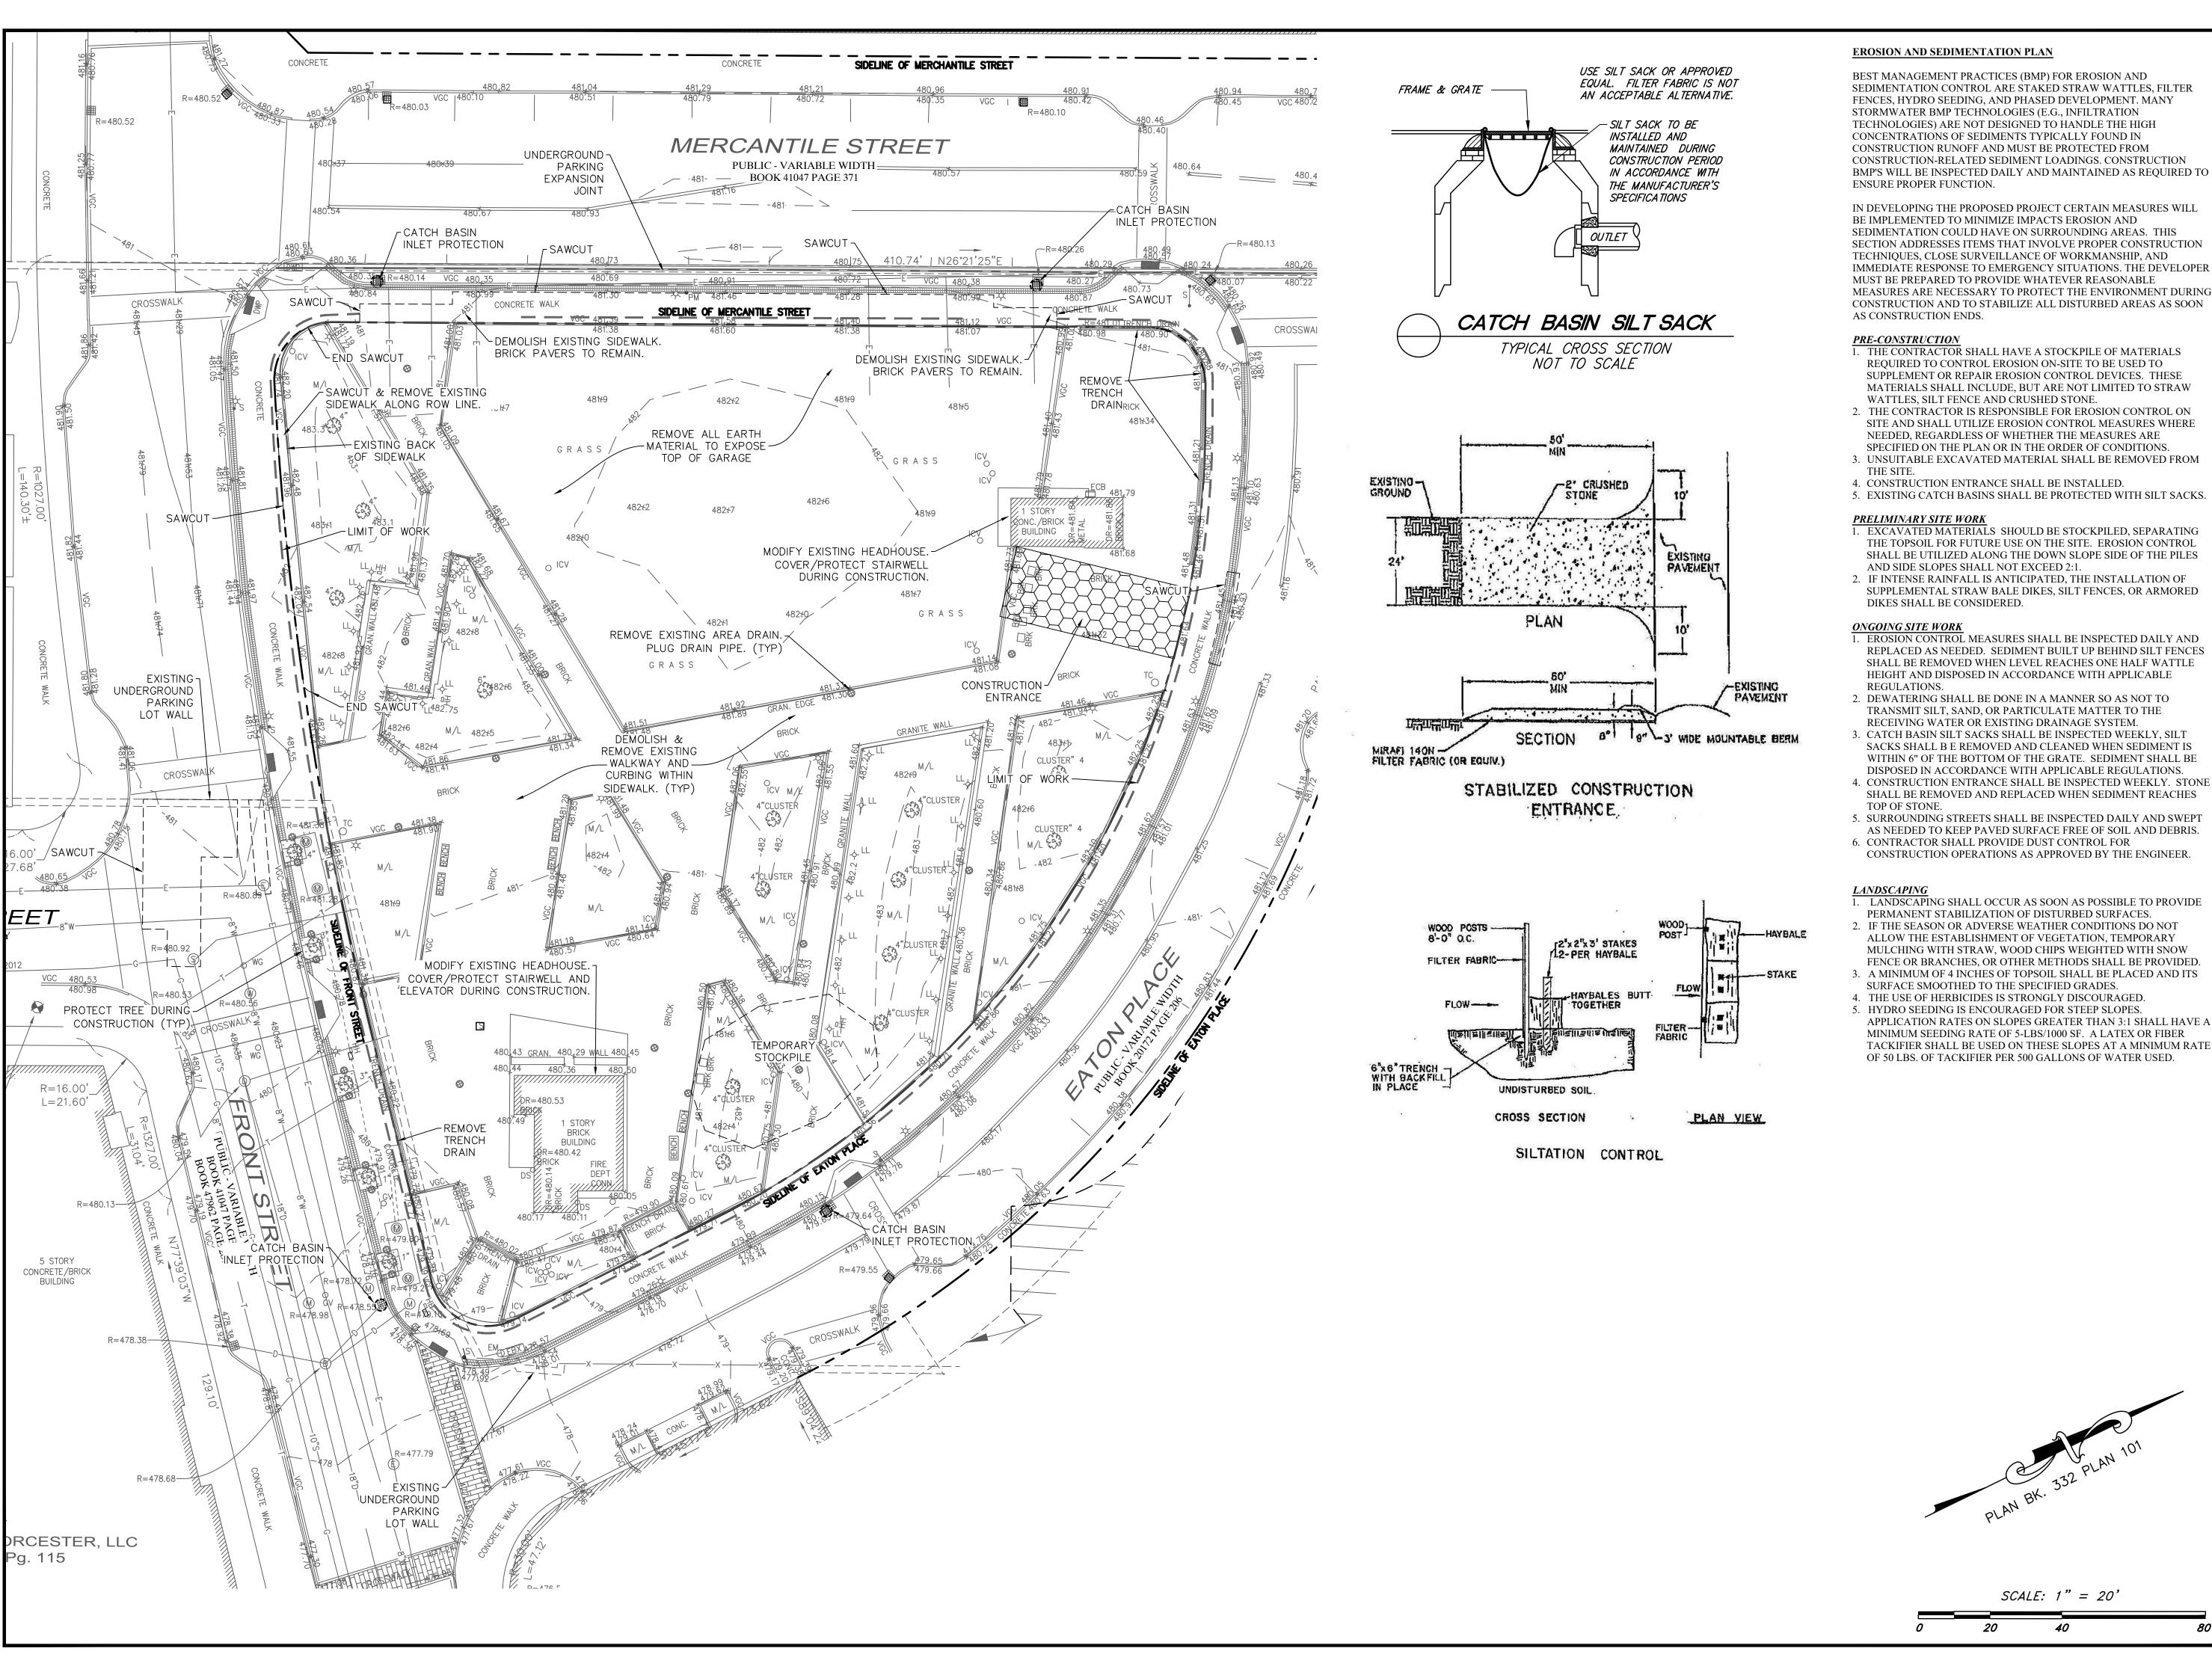
MANHOLE (UNKNOWN UTILITY) VERTICAL GRANITE CURB VERTICAL CONCRETE CURB ELECTRIC HAND HOLE

NOT FIELD OBSERVED NO PIPES VISIBLE TOP OF HOOD *BOLLARD*

CONNECTION UNKNOWN LANDSCAPE *TYPICAL* OPEN SPACE AREA DRAIN







BEST MANAGEMENT PRACTICES (BMP) FOR EROSION AND SEDIMENTATION CONTROL ARE STAKED STRAW WATTLES, FILTER FENCES, HYDRO SEEDING, AND PHASED DEVELOPMENT. MANY STORMWATER BMP TECHNOLOGIES (E.G., INFILTRATION TECHNOLOGIES) ARE NOT DESIGNED TO HANDLE THE HIGH CONCENTRATIONS OF SEDIMENTS TYPICALLY FOUND IN CONSTRUCTION RUNOFF AND MUST BE PROTECTED FROM CONSTRUCTION-RELATED SEDIMENT LOADINGS. CONSTRUCTION BMP'S WILL BE INSPECTED DAILY AND MAINTAINED AS REQUIRED TO

IN DEVELOPING THE PROPOSED PROJECT CERTAIN MEASURES WILL BE IMPLEMENTED TO MINIMIZE IMPACTS EROSION AND SEDIMENTATION COULD HAVE ON SURROUNDING AREAS. THIS SECTION ADDRESSES ITEMS THAT INVOLVE PROPER CONSTRUCTION TECHNIQUES, CLOSE SURVEILLANCE OF WORKMANSHIP, AND IMMEDIATE RESPONSE TO EMERGENCY SITUATIONS. THE DEVELOPER MUST BE PREPARED TO PROVIDE WHATEVER REASONABLE MEASURES ARE NECESSARY TO PROTECT THE ENVIRONMENT DURING CONSTRUCTION AND TO STABILIZE ALL DISTURBED AREAS AS SOON

- 1. THE CONTRACTOR SHALL HAVE A STOCKPILE OF MATERIALS REQUIRED TO CONTROL EROSION ON-SITE TO BE USED TO SUPPLEMENT OR REPAIR EROSION CONTROL DEVICES. THESE MATERIALS SHALL INCLUDE, BUT ARE NOT LIMITED TO STRAW
- 2. THE CONTRACTOR IS RESPONSIBLE FOR EROSION CONTROL ON SITE AND SHALL UTILIZE EROSION CONTROL MEASURES WHERE NEEDED, REGARDLESS OF WHETHER THE MEASURES ARE
- SPECIFIED ON THE PLAN OR IN THE ORDER OF CONDITIONS. 3. UNSUITABLE EXCAVATED MATERIAL SHALL BE REMOVED FROM
- 5. EXISTING CATCH BASINS SHALL BE PROTECTED WITH SILT SACKS.
- I. EXCAVATED MATERIALS SHOULD BE STOCKPILED, SEPARATING THE TOPSOIL FOR FUTURE USE ON THE SITE. EROSION CONTROL SHALL BE UTILIZED ALONG THE DOWN SLOPE SIDE OF THE PILES
- 2. IF INTENSE RAINFALL IS ANTICIPATED, THE INSTALLATION OF SUPPLEMENTAL STRAW BALE DIKES, SILT FENCES, OR ARMORED
- REPLACED AS NEEDED. SEDIMENT BUILT UP BEHIND SILT FENCES SHALL BE REMOVED WHEN LEVEL REACHES ONE HALF WATTLE HEIGHT AND DISPOSED IN ACCORDANCE WITH APPLICABLE
- 2. DEWATERING SHALL BE DONE IN A MANNER SO AS NOT TO TRANSMIT SILT, SAND, OR PARTICULATE MATTER TO THE
- 3. CATCH BASIN SILT SACKS SHALL BE INSPECTED WEEKLY, SILT SACKS SHALL B E REMOVED AND CLEANED WHEN SEDIMENT IS WITHIN 6" OF THE BOTTOM OF THE GRATE. SEDIMENT SHALL BE
- SHALL BE REMOVED AND REPLACED WHEN SEDIMENT REACHES
- 5. SURROUNDING STREETS SHALL BE INSPECTED DAILY AND SWEPT
- 6. CONTRACTOR SHALL PROVIDE DUST CONTROL FOR
- 1. LANDSCAPING SHALL OCCUR AS SOON AS POSSIBLE TO PROVIDE
- 2. IF THE SEASON OR ADVERSE WEATHER CONDITIONS DO NOT ALLOW THE ESTABLISHMENT OF VEGETATION, TEMPORARY
- FENCE OR BRANCHES, OR OTHER METHODS SHALL BE PROVIDED. 3. A MINIMUM OF 4 INCHES OF TOPSOIL SHALL BE PLACED AND ITS
- SURFACE SMOOTHED TO THE SPECIFIED GRADES. 4. THE USE OF HERBICIDES IS STRONGLY DISCOURAGED.
- 5. HYDRO SEEDING IS ENCOURAGED FOR STEEP SLOPES APPLICATION RATES ON SLOPES GREATER THAN 3:1 SHALL HAVE A MINIMUM SEEDING RATE OF 5-LBS/1000 SF. A LATEX OR FIBER TACKIFIER SHALL BE USED ON THESE SLOPES AT A MINIMUM RATE OF 50 LBS. OF TACKIFIER PER 500 GALLONS OF WATER USED.

SITE ADDRESS:

CITY SQUARE EATON PLACE

3 Eaton Place Worcester, Massachusetts 01608

ASSESSORS:

<u>MAP</u>	BLOCK	LOT
2	23B	00A-1

PREPARED FOR:

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125 Goff Avenue, Suite 2101 Pawtucket, RI 02860

HANCOCK ASSOCIATES

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NO. BY APP DATE ISSUE/REVISION DESCRIPTION DATE: 9/28/2023 DESIGN BY: SCALE: 1"=20' DRAWN BY: APPROVED BY: JDP CHECK BY:

DEMOLITION, **EROSION & SEDIMENT** CONTROL PLAN

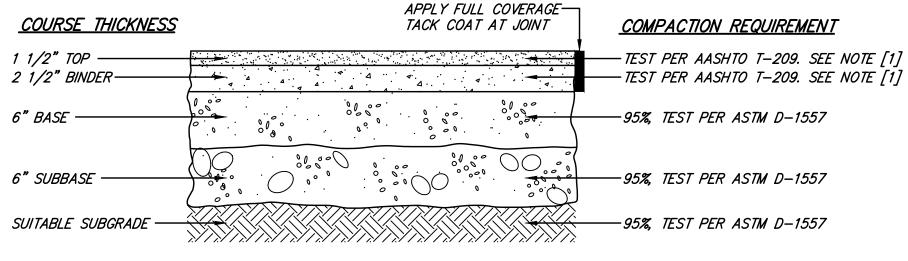
PLOT DATE: Sep 27, 2023 12:54 pm

5 OF 7

DWG: 26660DSP.dwg AYOUT:

26660

PROJECT NO.:




[1] COMPACT TO TEST AVERAGE OF 95%, ±2.5%

[2] CONTRACTOR TO CONFIRM EXISTING DEPTH OF PAVEMENT ON TRUMBULL STREET AND COORDINATE WITH THE WORCESTER DEPARTMENT OF PUBLIC WORKS ON DEPTH OF PAVEMENT TO BE INSTALLED.

MA TERIAL	SPECIFICA TION	MAXIMUM AGGREGATE OR PARTICLE SIZE (IN.)
TOP - BITUMINOUS CONCRETE	MHD M3.11.03 CLASS I, TYPE I—1	1/2
BINDER- BITUMINOUS CONCRETE	MHD M3.11.03 CLASS I, TYPE I-1	1
BASE - DENSE GRADED CRUSHED STONE	MHD M2.01.7	1 1/2
SUBBASE - GRAVEL BORROW	MHD M1.03.0 TYPE C	2


BITUMINOUS CONCRETE PAVEMENT

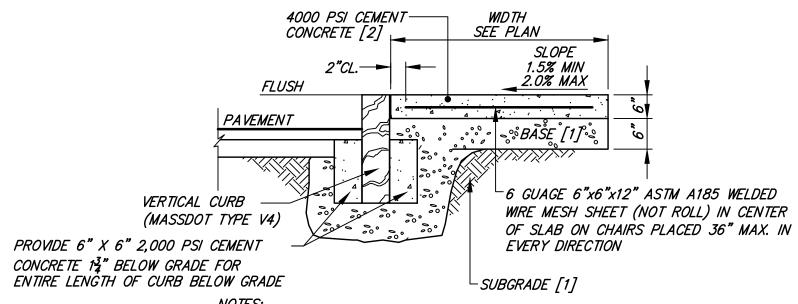TYPICAL CROSS SECTION NOT TO SCALE




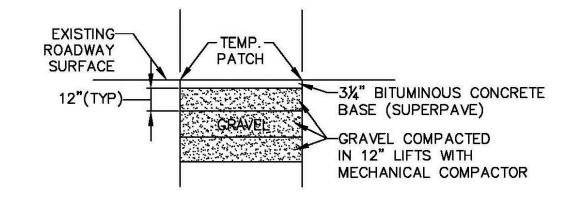[1] COMPACT TO 95% PER ASTM D-1557 (IN 6" LIFTS). OCEAN AVENUE SIDEWALK BASE SHALL BE MDOT M1.03.0 TYPE C. [2] CONTROL JOINT EVERY 5 LF, EXPANSION JOINT EVERY 50 LF.






TEMPORARY PATCH

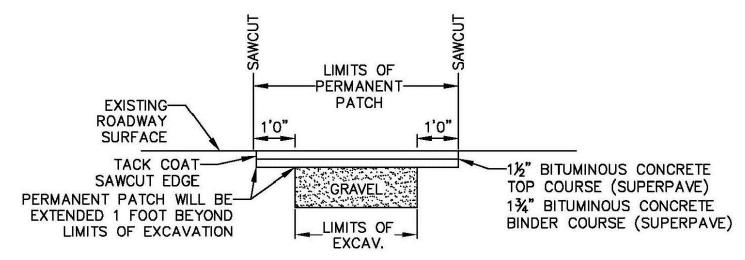

PERMANENT PATCH FOR ROADS HAVING A PAVING BLOCK OR CONCRETE BASE SHALL INCLUDE A LAYER OF CONCRETE EQUAL TO THE DEPTH OF THE EXISTING CONCRETE OR PAVING BLOCK. IN SUCH CASES THE DEPTH OF THE GRAVEL BACKFILL SHALL NOT BE LESS THAN 12 INCHES.

PERMANENT PATCH

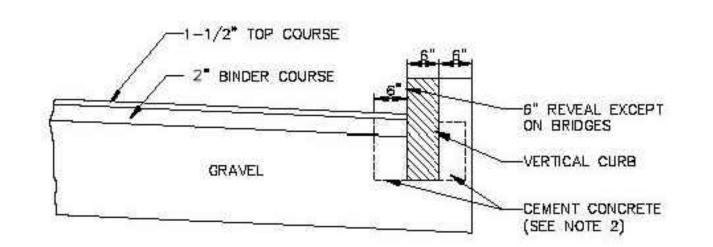
TYPICAL TEMPORARY/PERMANENT PATCH DETAIL FOR ROADWAY





NOTES: 1. CUT NEAT LINE 6" FROM CURB LINE AND REMOVE BINDER, BASE AND STONE, REPLACE WITH CEMENT CONCRETE.

- 2. ANY CLASS CEMENT CONCRETE THAT IS ACCEPTABLE TO THE DEPARTMENT UNDER SECTION M4 OF THE 1973 STANDARD SPECIFICATIONS, ALL TEST REQUIREMENTS ARE WAIVED, BITUMINOUS CONCRETE SHALL NOT BE USED AS A
- 3. PAYMENT FOR CLASS B CONCRETE WILL BE PAID FOR UNDER ITEM 446.1.

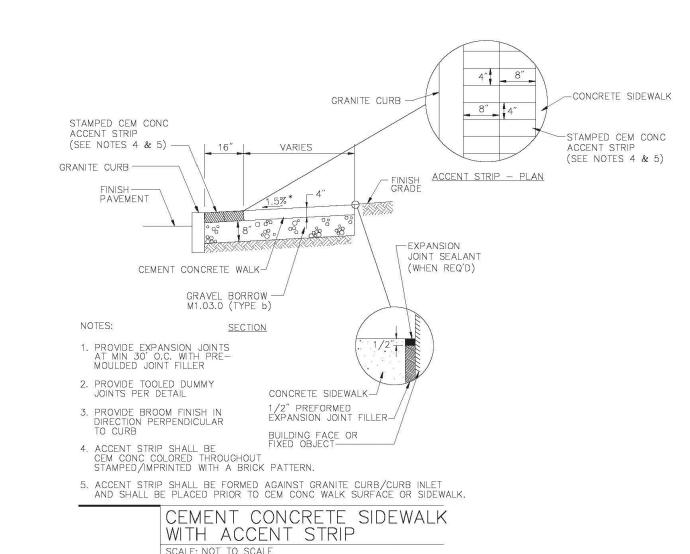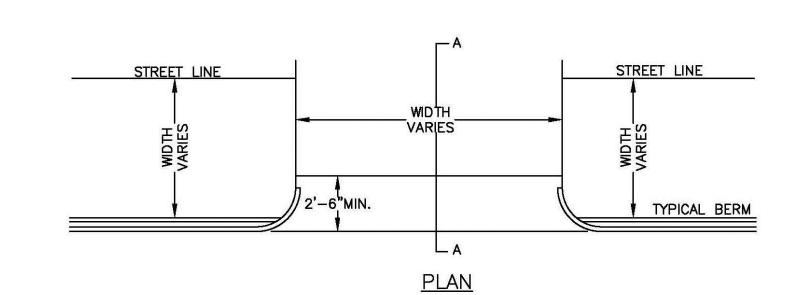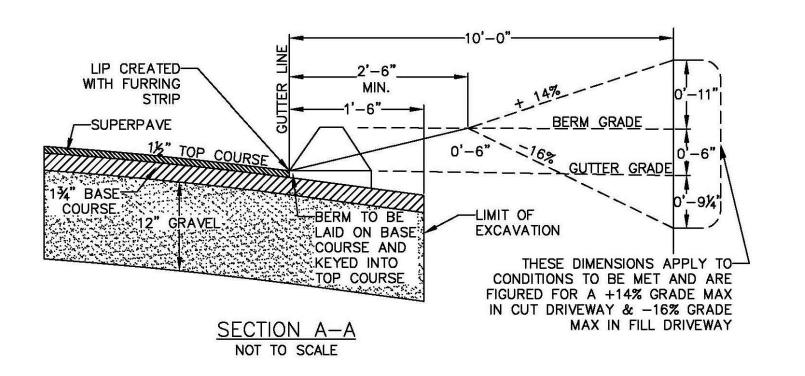METHOD OF SETTING VERTICAL CURB







TYPICAL DRIVEWAY

SITE ADDRESS:

CITY SQUARE EATON PLACE

3 Eaton Place Worcester, Massachusetts 01608

ASSESSORS:

MAP	BLOCK	<u>LOT</u>
2	23B	00A-1

PREPARED FOR:

FORESIGHT CAPITAL LLC

125 Goff Avenue, Suite 2101 Pawtucket, RI 02860

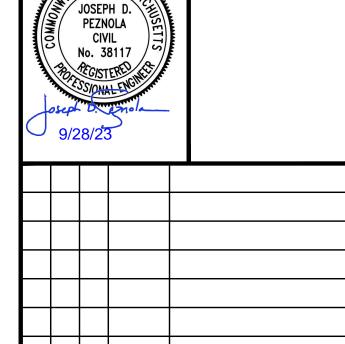
HANCOCK ASSOCIATES

Civil Engineers

Land Surveyors

Environmental Consultants

315 Elm Street, Marlborough, MA 01752 Voice (508) 460-1111, Fax (508) 460-1121 www.hancockassociates.com



NO. BY APP DATE ISSUE/REVISION DESCRIPTION 9/28/2023 DESIGN BY: --- DRAWN BY: RMD

APPROVED BY: JDP CHECK BY:

DETAIL

SHEET 1

PLOT DATE: Sep 27, 2023 12:54 pm DWG: 26660DSP.dwg LAYOUT:

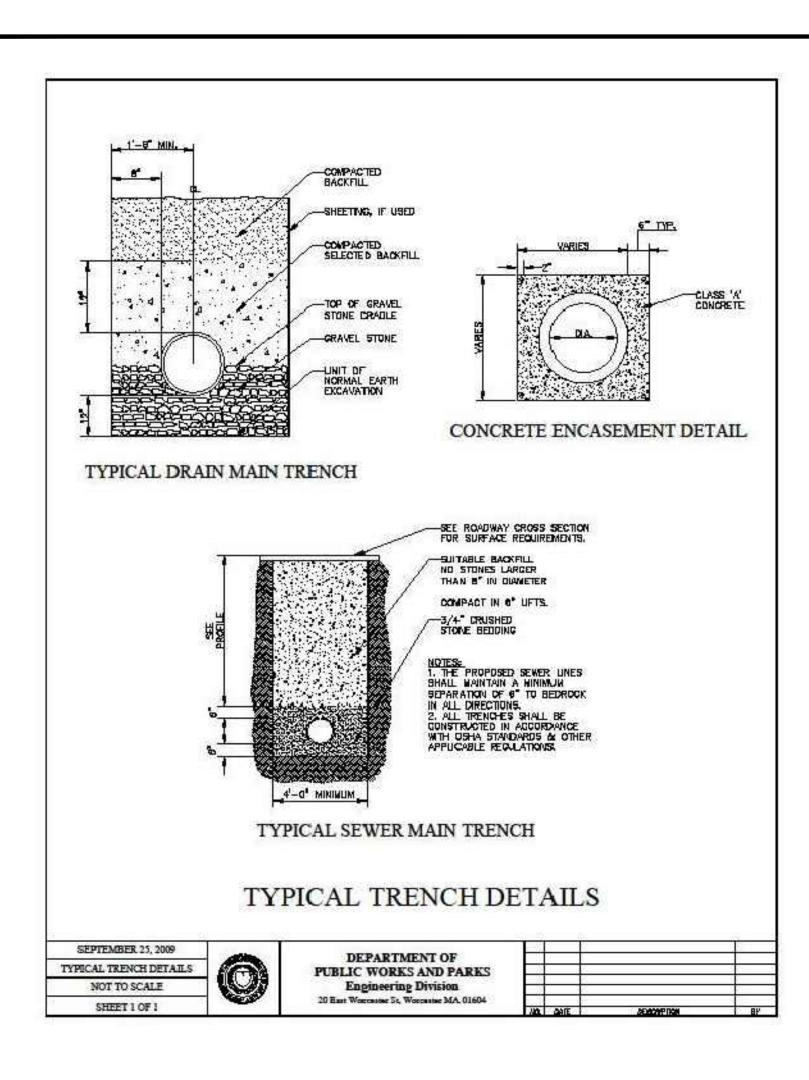
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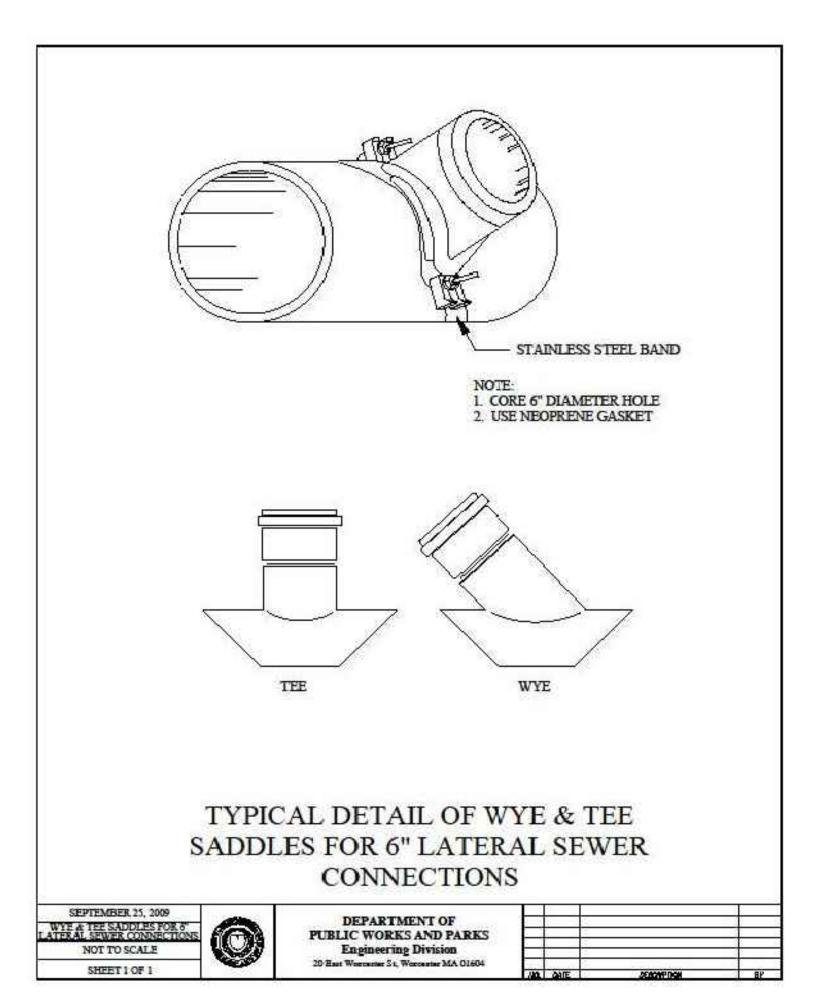
PROJECT NO.:


DET1 6 OF 7

26660

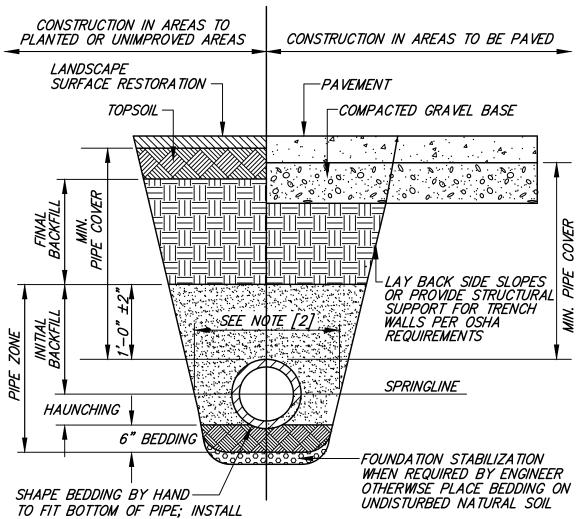KAC







PIPE ON STABLE BEDDING WITH UNIFORM BEARING UNDER FULL LENGTH OF PIPE BARREL.

FOUNDATION, BEDDI	NG, & BACKFI	LL MATERIALS	<u>NOTES:</u> [1]	RADED
PIPE MATERIAL	HDP, PVC	RC, DI	GRANULÁR BACK OPTIMUM MOISTU	
FOUNDATION STABILIZATION	[6]	[6]	HORIZONTAL, 8". LOOSE LAYERS;	COMPACT
BEDDING	[1]	[1]	TO 95% PER AS	
HAUNCHING	[1]	[1]	MEASURED AT TO OF THE PIPE, IN	HE SPRIN
INITIAL BACKFILL	[1]	[1]	NECESSARY SHE	
FINAL BACKFILL	[4]	[4]	PIPE I.D. LESS THAN 21"	<i>WIDTH</i> 0.D. + 1
MIN. PIPE COVER	[5]	[5]	21" TO 42" GREATER THAN 42"	0.D. + 2 0.D. + 3

NUM MOISTURE IN ZONTAL, 8"-DEEP, SE LAYERS; COMPACT 5% PER ASTM D-1557. IUM WIDTH OF TRENCH SURED AT THE SPRINGLINE HE PIPE, INCLUDING ANY SSARY SHEATHING: O.D. + 12" O.D. + 24" | GREATER THAN 42" | O.D. + 30" [5]

[3] INSTALL PIPE IN CENTER OF TRENCH.


[4] IN PLANTED OR UNIMPROVED AREAS, USE ON-SITE EXCAVATED MATERIAL FOR FINAL BACKFILL. COMPACT TO 95% PER ASTM D-1557. IN PAVED AREAS, OBTAIN ENGINEER APROVAL OF ON-SITE EXCAVATED MATERIALS FOR USE AS FINAL BACKFILL.

[5] MINIMUM COVER OVER TOP OF PIPE:


PIPE MATERIAL	HDP, PVC	RC, DI
WA TER	<i>5'-0"</i>	<i>5'-0"</i>
SEWER	4'-0"	4'-0"
DRAIN	1'-6"	1'-0"

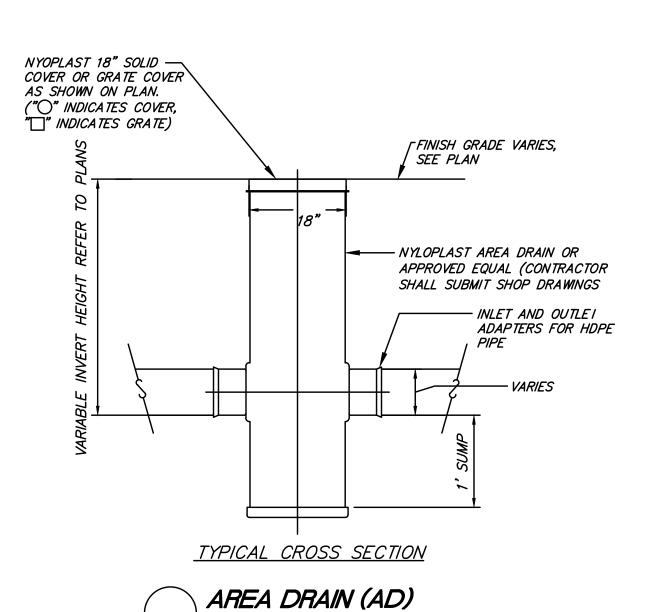[6] FOR FOUNDATION STABILIZATION, USE 2"± CRUSHED STONE.






NOT TO SCALE

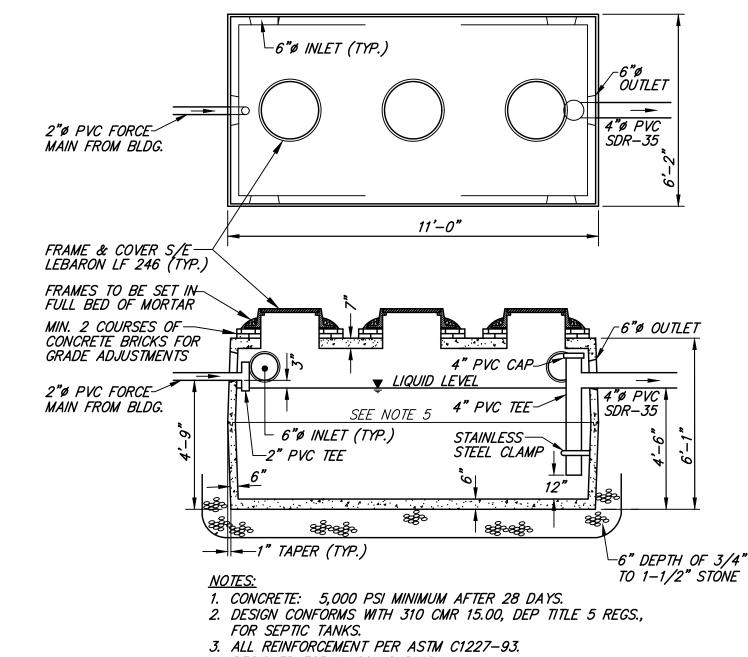

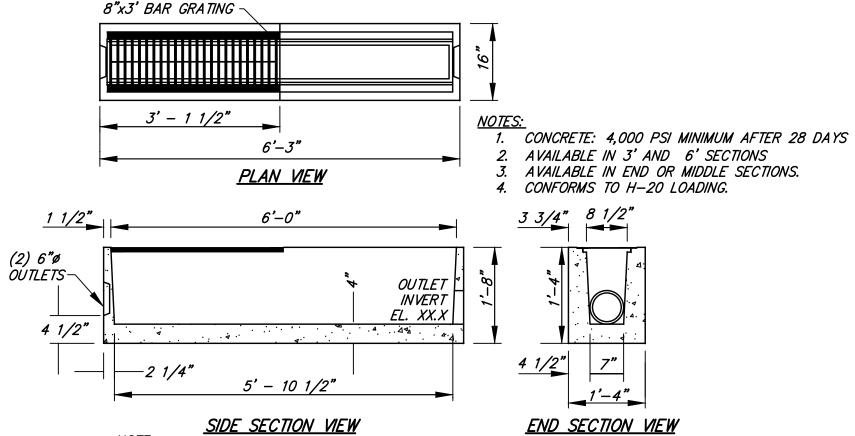
- 4. DESIGNED FOR H-20 LOADING.
- 5. TONGUE-&-GROOVE JOINT SEALED WITH BUTYLE RESIN. 6. TEES SOLD SEPARATELY.





TRENCH DRAIN TO BE MANUFACTURERED BY SHEA CONCRETE ITEM #M-TD6 (6' SECTIONS), OR EQUAL. SEE PLAN FOR SECTIONS REQUIRED. SUBMIT SHOP DRAWINGS.

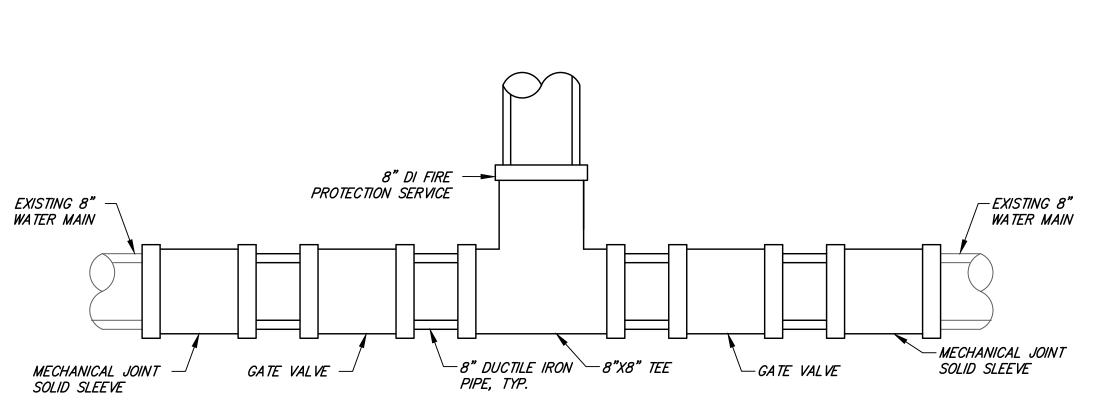TRENCH DRAIN NOT TO SCALE



FIRE PROTECTION SERVICE CONNECTION ASSEMBLY NOT TO SCALE

SITE ADDRESS:

CITY SQUARE EATON PLACE

3 Eaton Place Worcester, Massachusetts 01608

ASSESSORS:

BLOCK 23B 00A-1

PREPARED FOR:

FORESIGHT CAPITAL LLC

125 Goff Avenue, Suite 2101 Pawtucket, RI 02860


HANCOCK ASSOCIATES


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> **DETAIL** SHEET 2

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DWG: 26660DSP.dwg AYOUT: DET2

SHEET: 7 OF 7

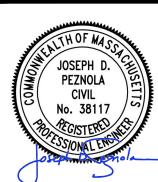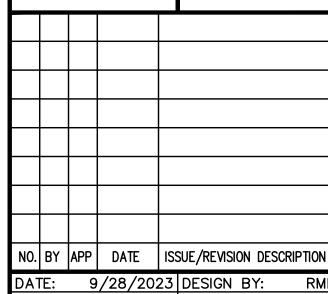PROJECT NO.:

26660